
GENERAL INFORMATION Address: 2342 Tremont Road Upper Arlington, Ohio 43221 Parcel: 070-000984-00 Scope of Project: The project consists of the following: First floor renovation with reconfiguration of spaces. Second floor renovation with reconfiguration of spaces. Removal of radiant heating system & installation of new furnace. New electric & lighting throughout. Interior cosmetic improvements including new flooring and painting. Total First Floor SF: Total Second Floor SF: 2,064 sf 3,684 sf Total House SF: Attached Garage SF: 808 sf Kutasay Residence 2342 Tremont Road Upper Arlington, Ohio 43221 Architect: Brenda Parker ZONING: R-1C The Columbus Architectural Studio 405 N Front Street Zoning Req't 12,000 sf Lot Area & Lot Width Columbus, Ohio 43215 Lot Area: 13,875 sf t: 614.586.5514 brenda.parker@cbusarch.com Lot Width: Varies Building Cover Limit
Bldg Cover: Actual Zoning Req't 2,469 sf (18%) 4,023 sf (29%) Meets Zoning Zoning Reqt 12,960 sf (40%) Development Cover Limit Actual Dvpmt Cover: PROPERTY LINE 136.10 Building Cover: 2,469 sf 1,832 sf Driveway & Walks: Front Steps: 18 sf Rear Patio 297 sf New front patio: Dvpmt Cover Total: 4,691 sf (34%) Meets Zoning Existing paver patio; 297 sf. Patch pavers where basement window well was removed due to new french doors. Existing paver 24.65 driveway & walkways; 1,832 sf — SHEET INDEX A1.0 Site Plan & General Info A3.1 First Floor Finish Plans Existing House (incl attached garage 2,443 sf (footprint) Existing covered A2.0 Basement Plans A3.2 Second Floor Finish Plans porch; 26 sf — A2.1 First Floor Plans A4.1 Interior Elevations A2.2 Second Floor Plans A4.2 Interior Elevations Infill existing mulch YORKSHIRE ROAD MEP.0 Basement MEP Plans bed w/ pavers to MEP.1 First Floor MEP Plans match existing; 75 sf. — MEP.2 Second Floor MEP Plans concrete steps; 18 sf. **DESIGN CRITERIA** 2019 Residential Code of Ohio Design Criteria: Wind Speed = 115 mph Seismic Category = A Weathering = Severe Frost Line Depth = 36" Termite = Moderate to Heavy Ice Barrier Underlayment = Yes, Required. Floor Live Load = 40 psf CH=78.12 Snow Load Roof = 20 psf Foundation Concrete Compressive Strength = 2,500 Slab Concrete Compressive Strength = 3,000; air-entrained 5%-7% TREMONT ROAD FIREBLOCKING NOTES Fireblocking shall be provided i nwood frame construction in the following 1. In concealed spaces of stud walls and partitions, including furred spaces and parallel rows of studs or staggered studs, as follows: 1.1. Vertically at the ceiling and floor levels. 1.2. Horizontall at intervals not exceeding 10 feet. 2. At all interconnections between concealed vertical and horizontal spaces such as occur at soffits, drop ceilings, and cove ceilings. 3. In concealed spaces between stair stingers at the top and bottom of the run. Enclosed spaces under stairs shall comply with Section 302.7. 4. At openings around vents, pipes, ducts, cables, and wires at ceiling and floor level, with an approved material to resist the free passage of flame and products of combustion. The material filling this annular space shall not be required to meet the ASTM E136 requirements. 5. For the fireblocking of chimneys and fireplaces, see Section 1003.19. 6. In buildings or structures with more than one dwelling, fireblocking of cornices is required at the line of dwelling unit separation. Fire blocking materials: 1. Two-inch nomial lumber. 2. Two thicknesses of 1-inch nominal lumber with broken lap joints. 3. One thickness of 23/32-inch wood structural panels with joints backed by 23/32-inch wood structural panels. 4. One thickness of 1/4-inch particleboard with joints backed by 1/4-inch particleboard. 5. One-half-inch gypsum board. SITE PLAN &


2342 Tremont Road Upper Arlington, Ohio 43221


July 2, 2024

Permit Set 2342 TR

GENERAL INFORMATION

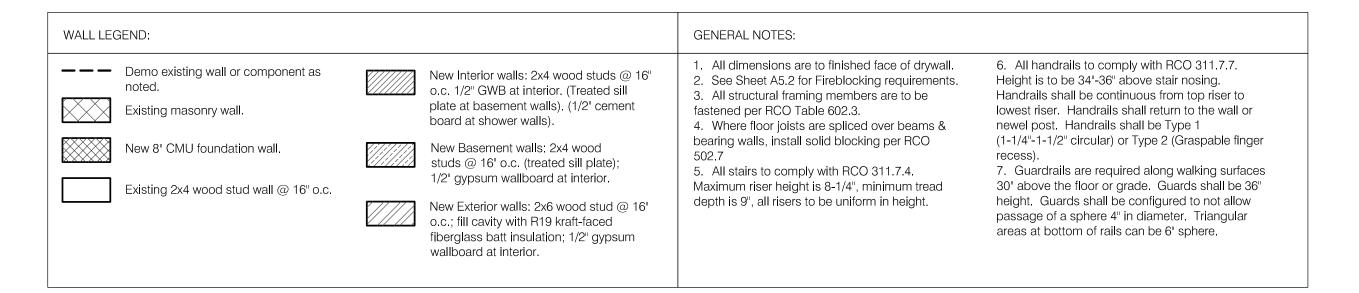

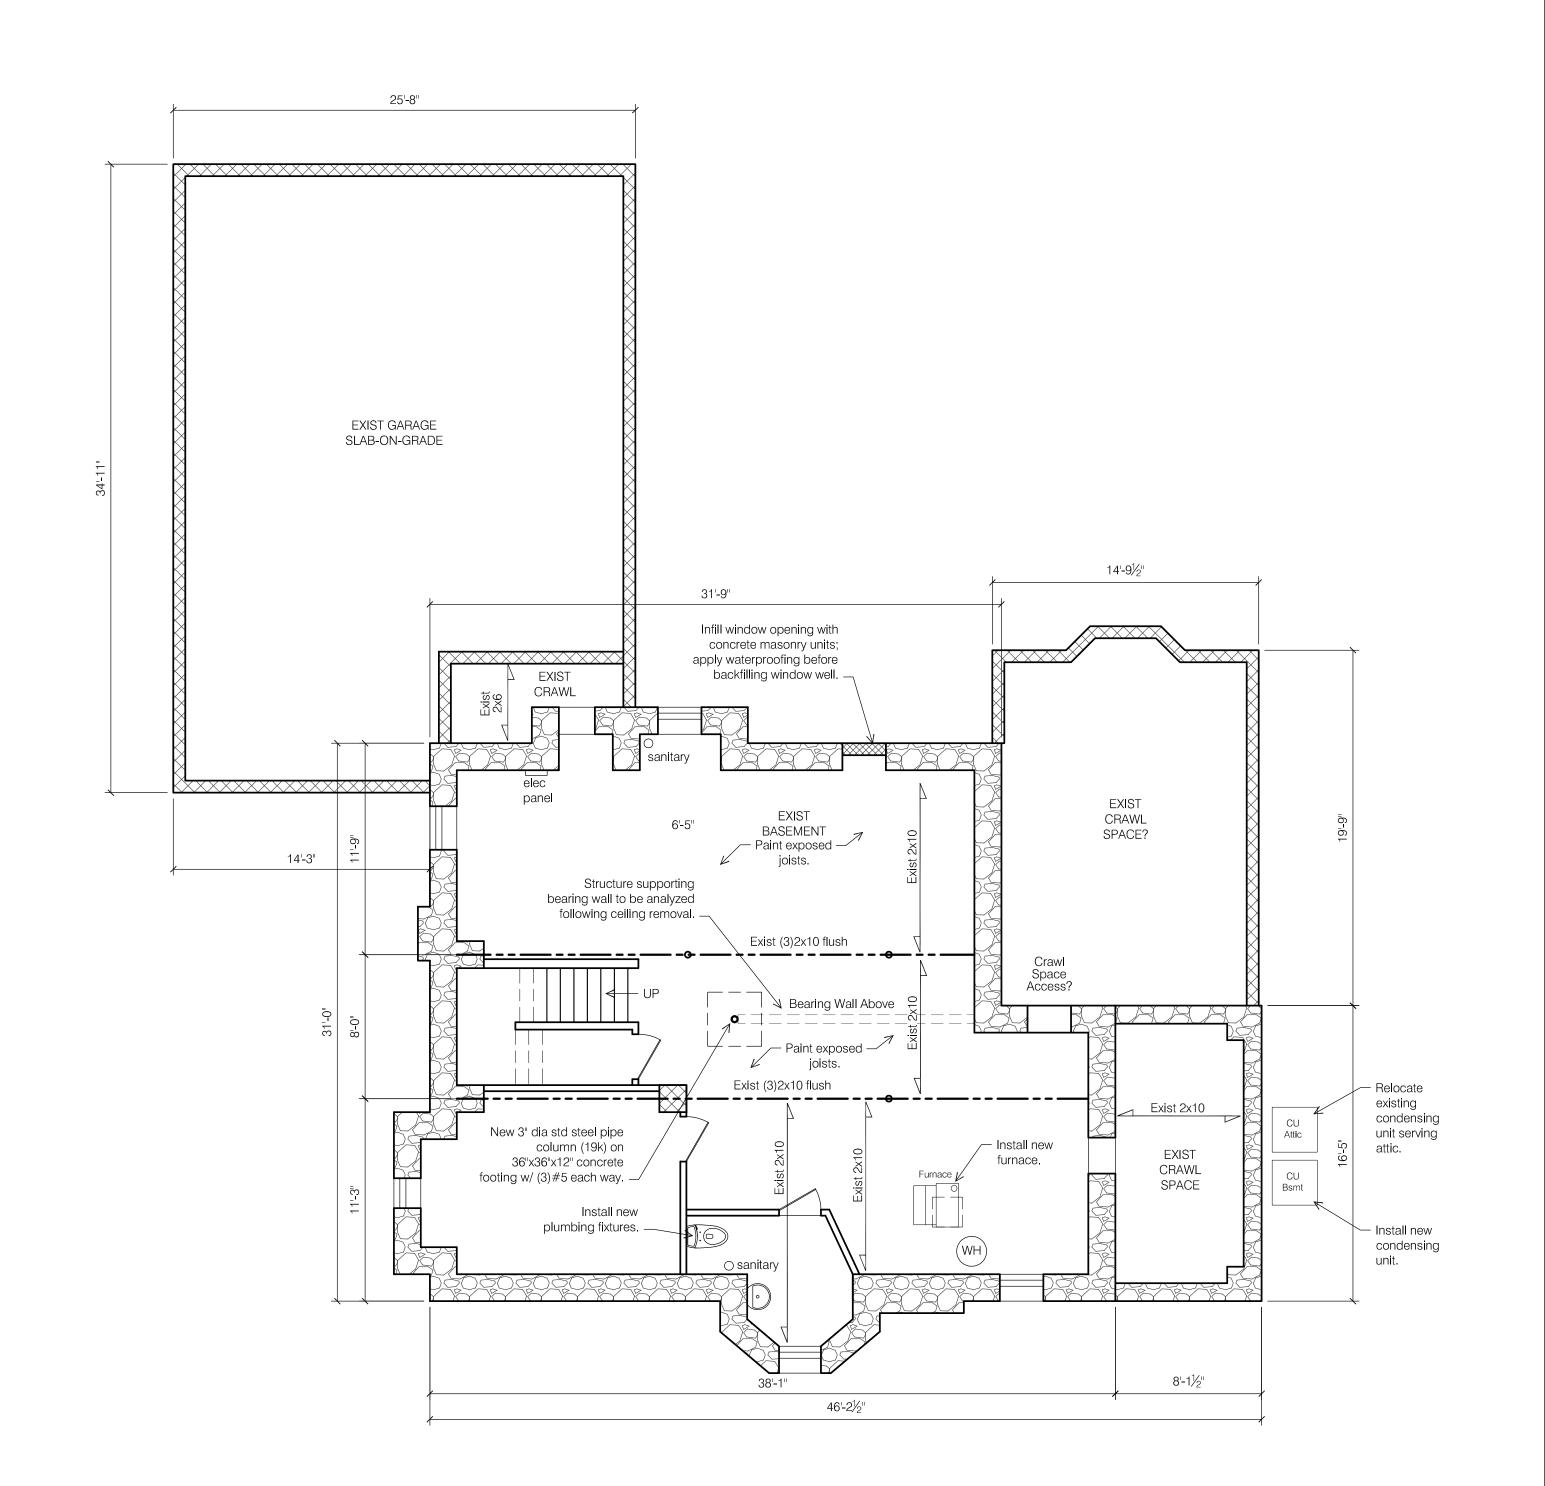

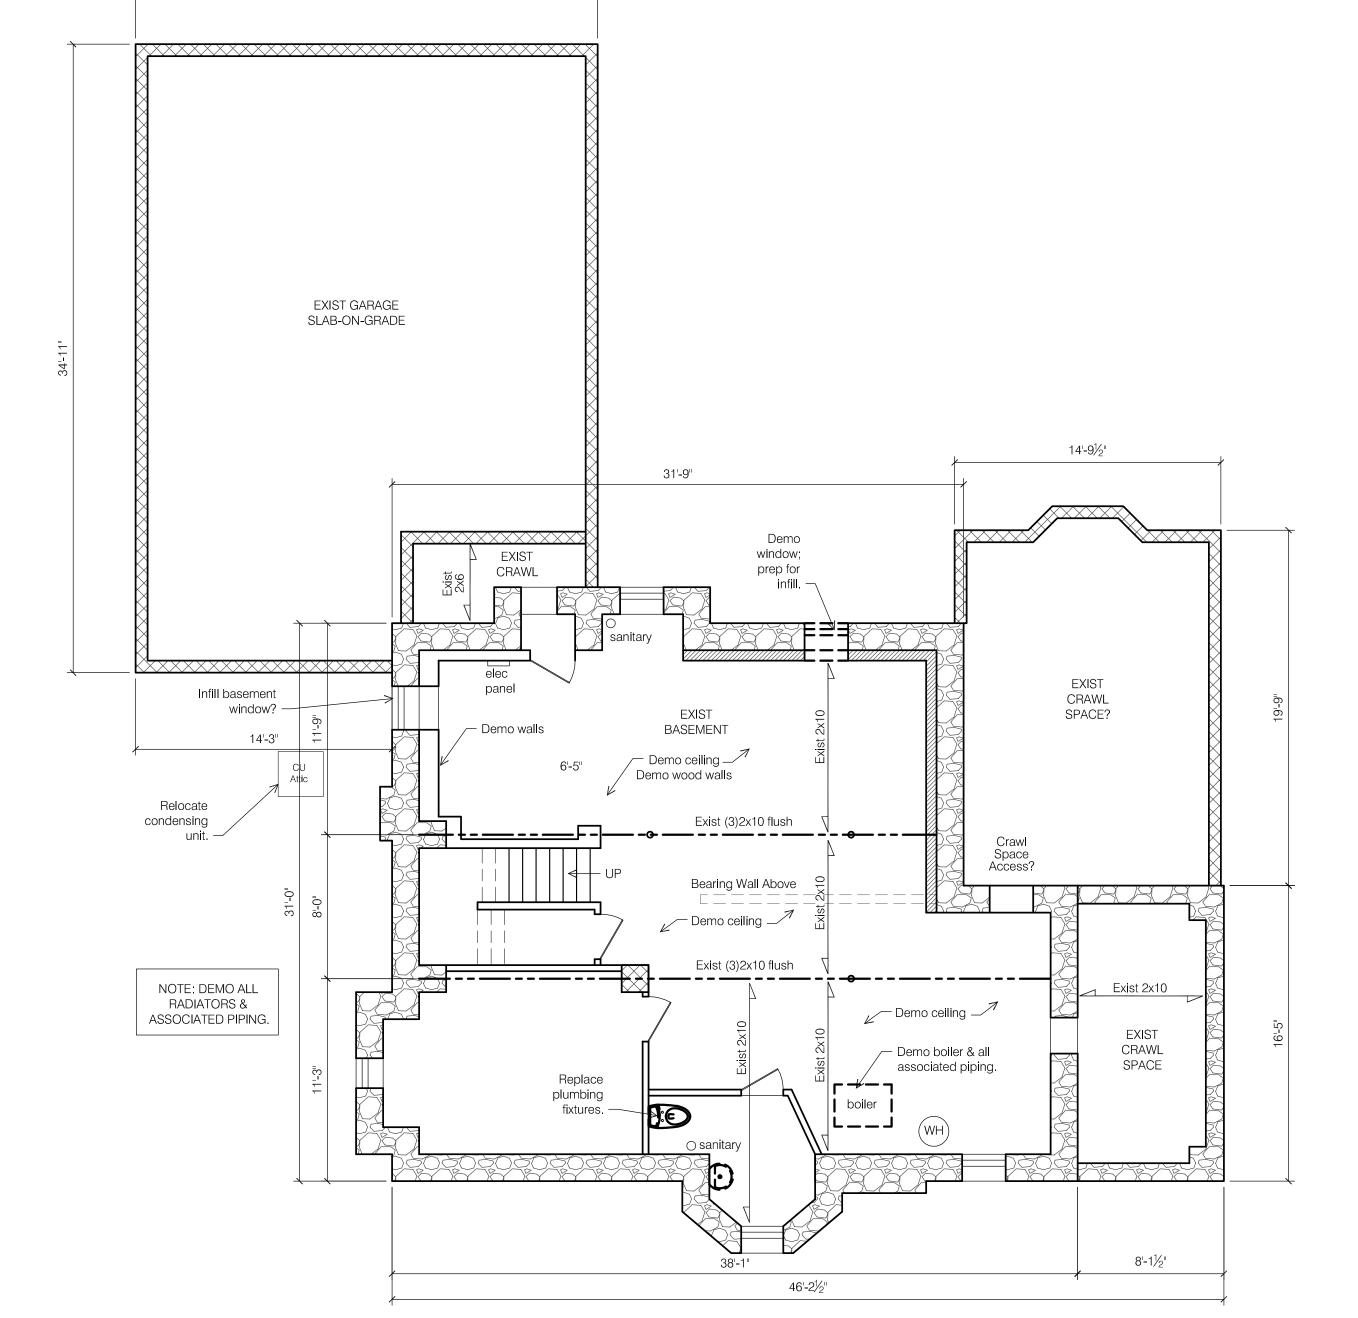

25'-8"

1 BASEMENT PLAN - DEMO

SCALE: 3/16" = 1'-0"

BASEMENT PLAN - NEW WORK
SCALE: 3/16" = 1'-0"

Δ2 N

BASEMENT

PLANS

July 2, 2024

Permit Set

2342 TR

2342 Tremont Road

Kutasay Residence 2342 Tremont Road Upper Arlington, Ohio 43221

Architect:


Brenda Parker


405 N Front Street Columbus, Ohio 43215 t: 614.586.5514


The Columbus Architectural Studio


brenda.parker@cbusarch.com

Upper Arlington, Ohio 43221

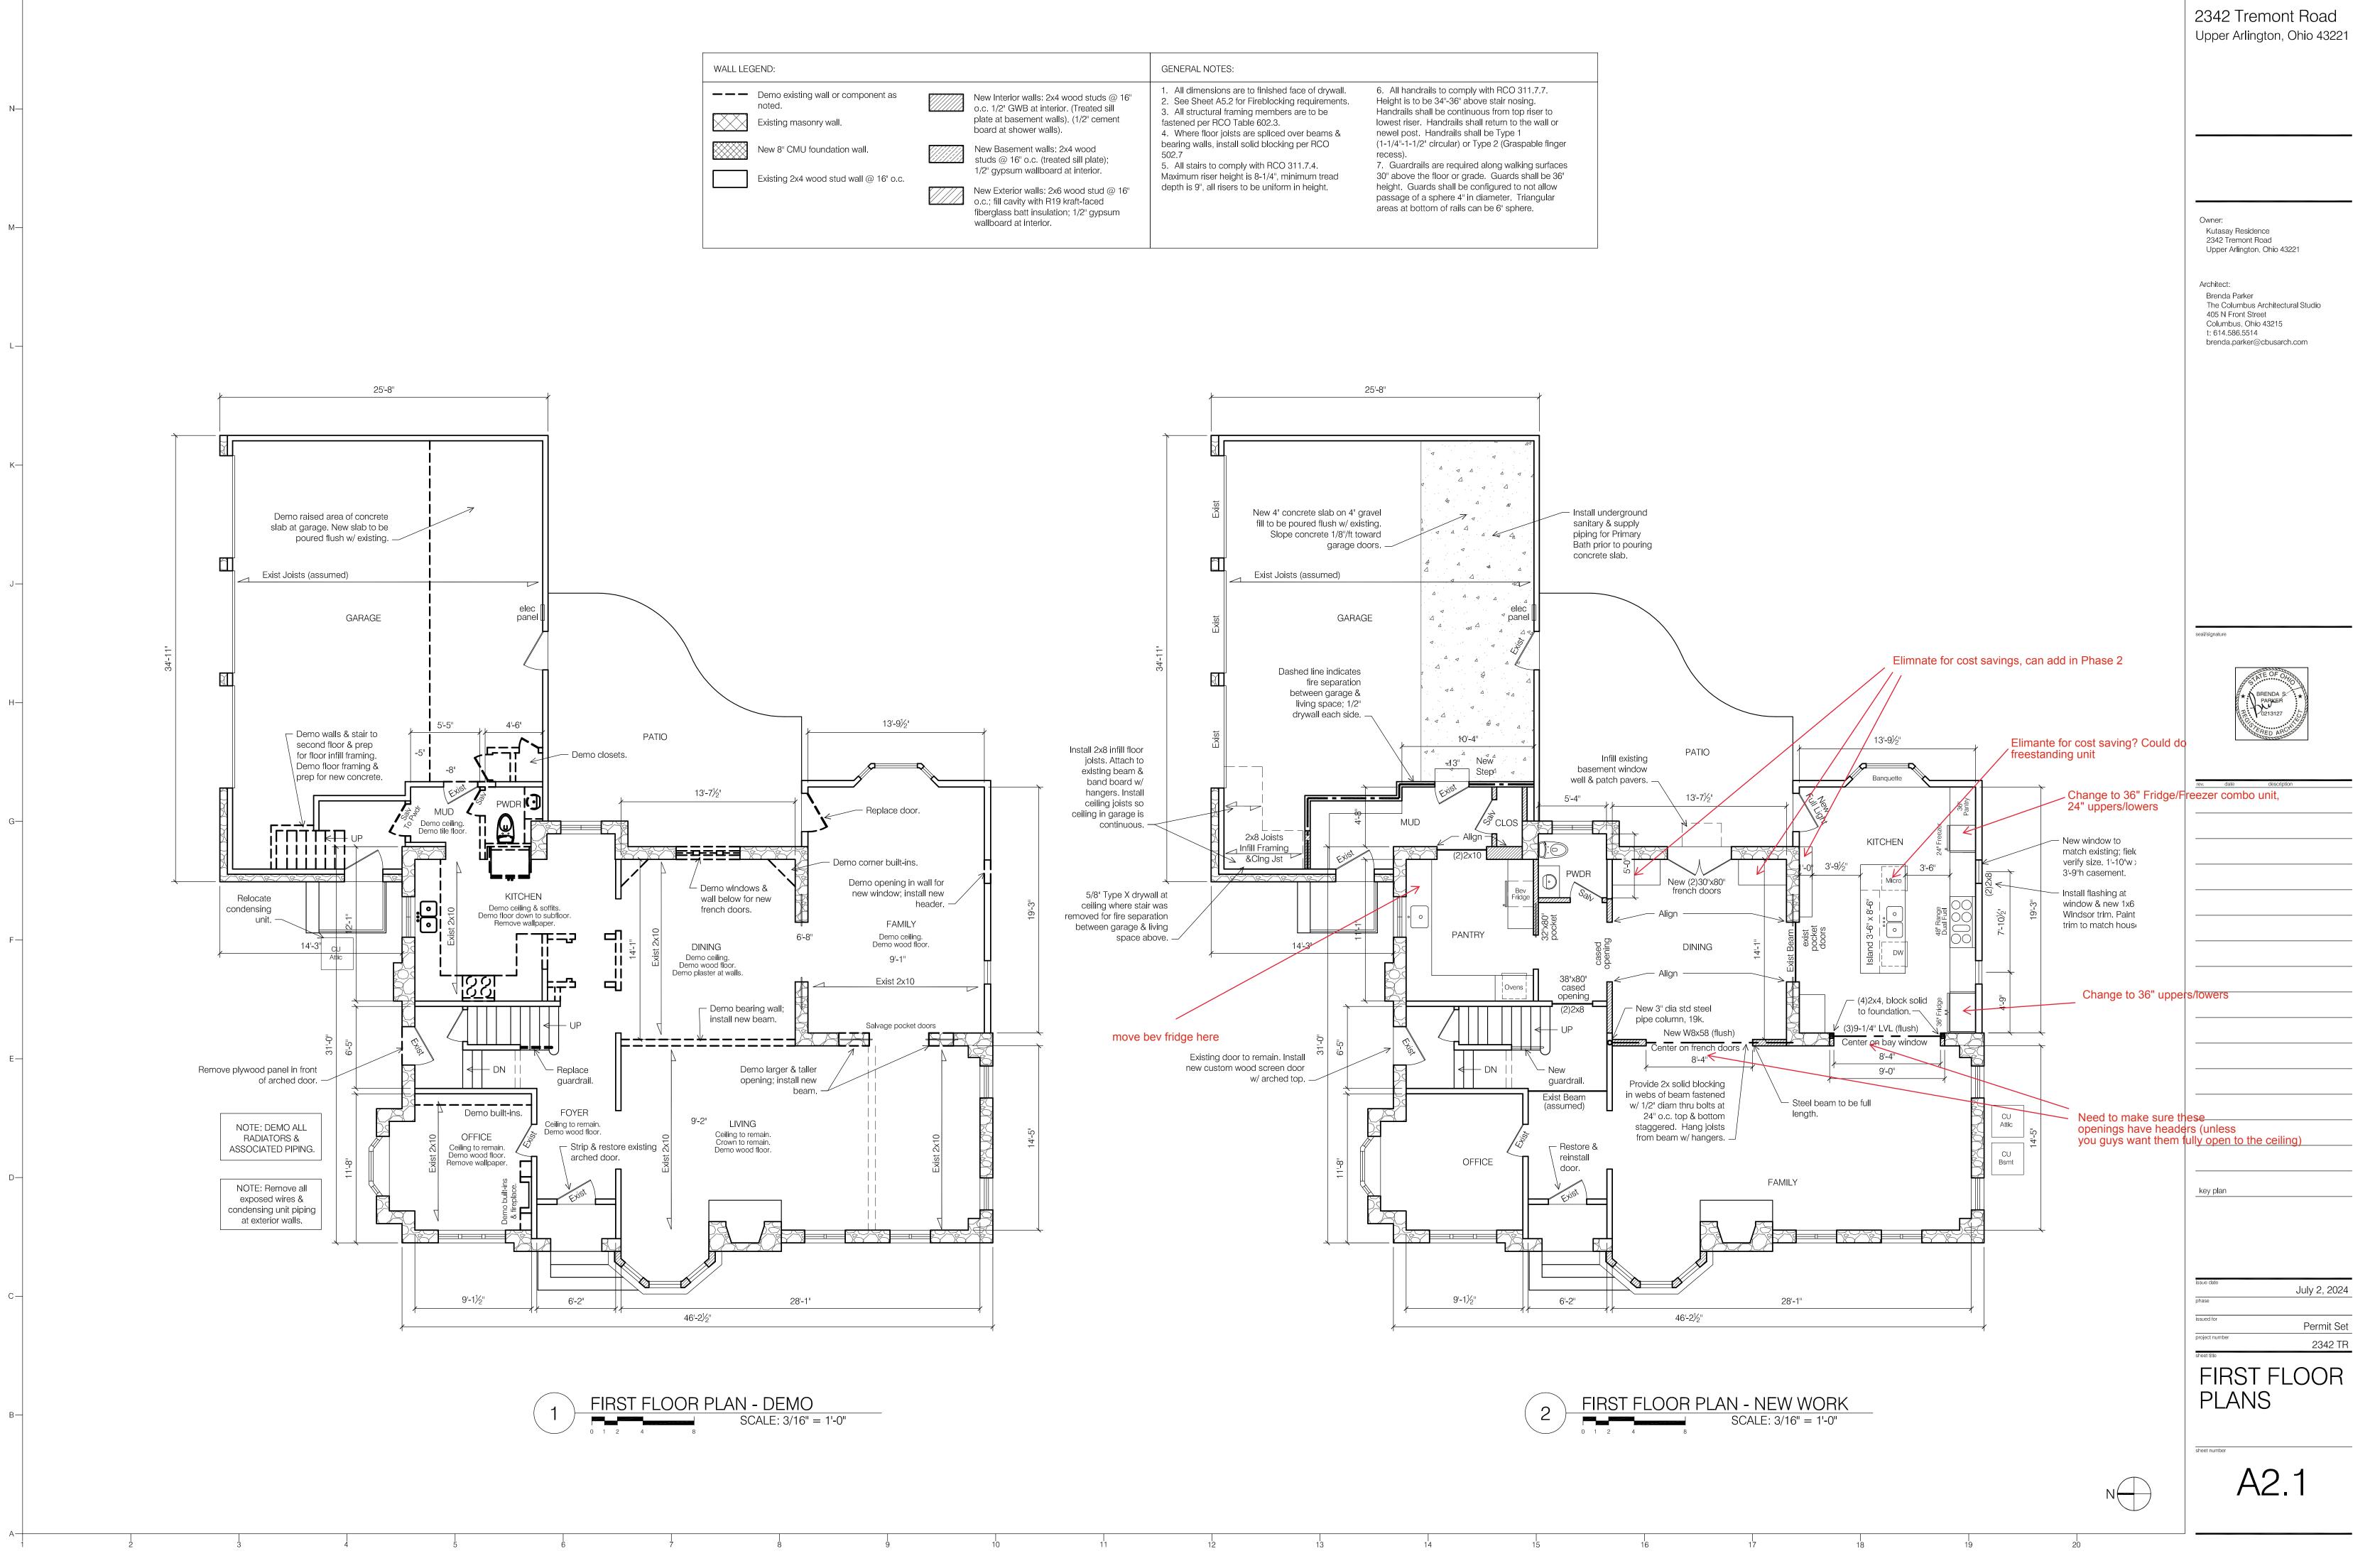

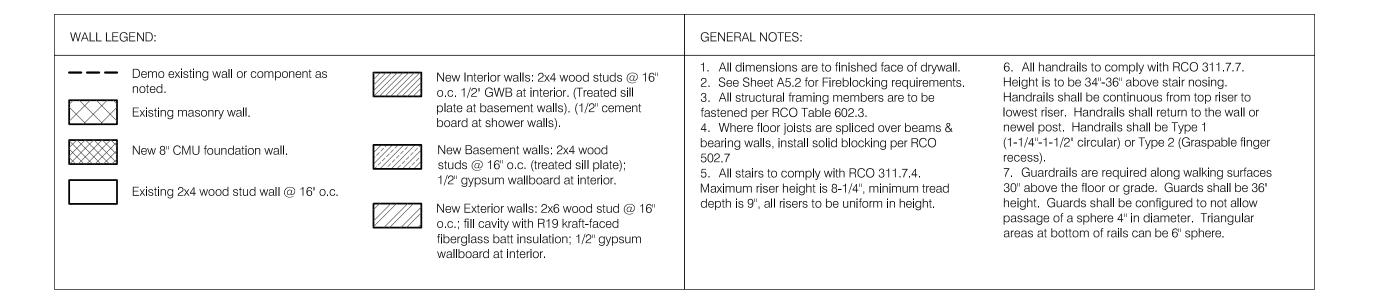

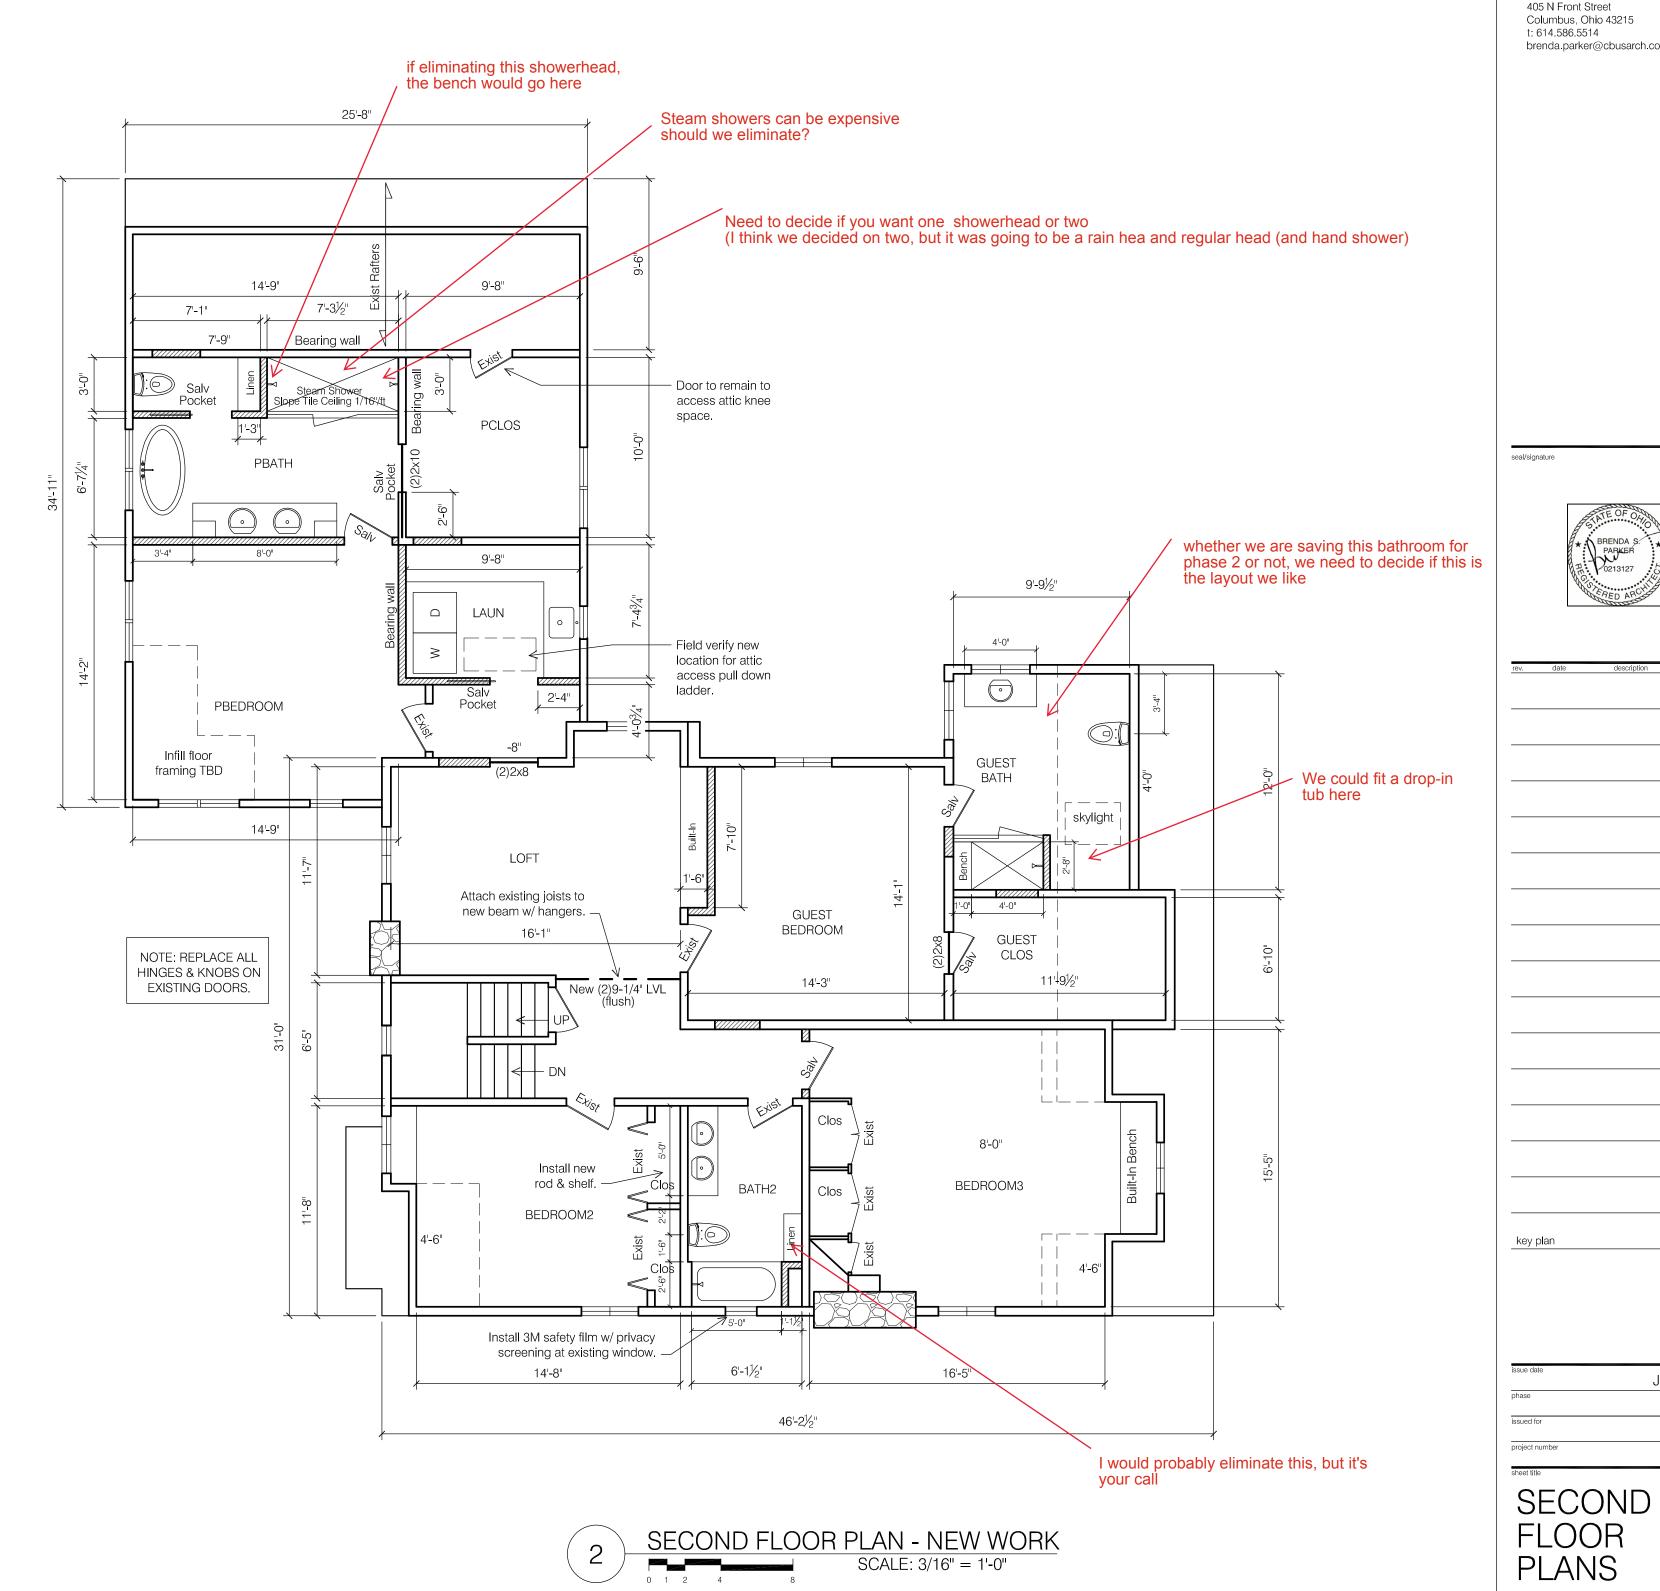

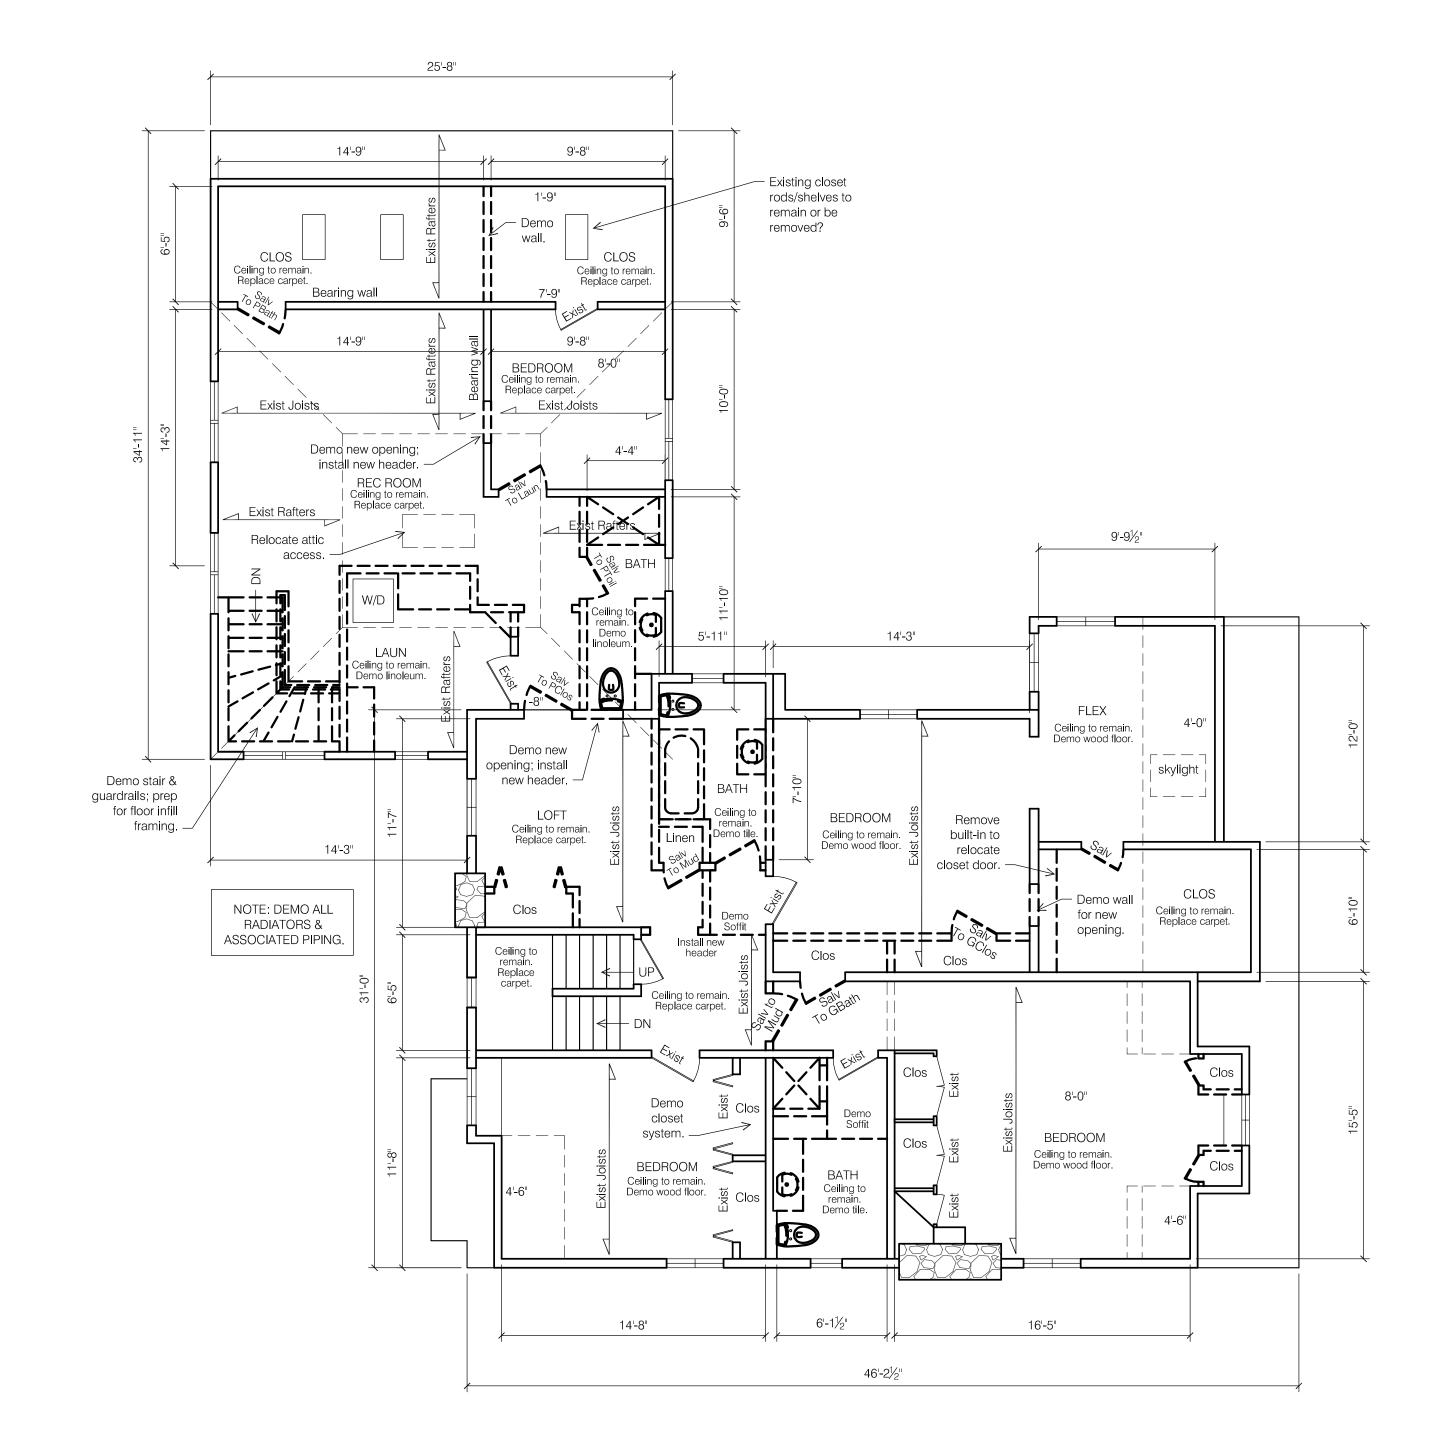

SECOND FLOOR PLAN - DEMO

SECOND FLOOR PLAN - NEW WORK

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2342 Tremont Road

Kutasay Residence 2342 Tremont Road Upper Arlington, Ohio 43221

Architect:


Brenda Parker

405 N Front Street Columbus, Ohio 43215 t: 614.586.5514

The Columbus Architectural Studio

brenda.parker@cbusarch.com

Upper Arlington, Ohio 43221

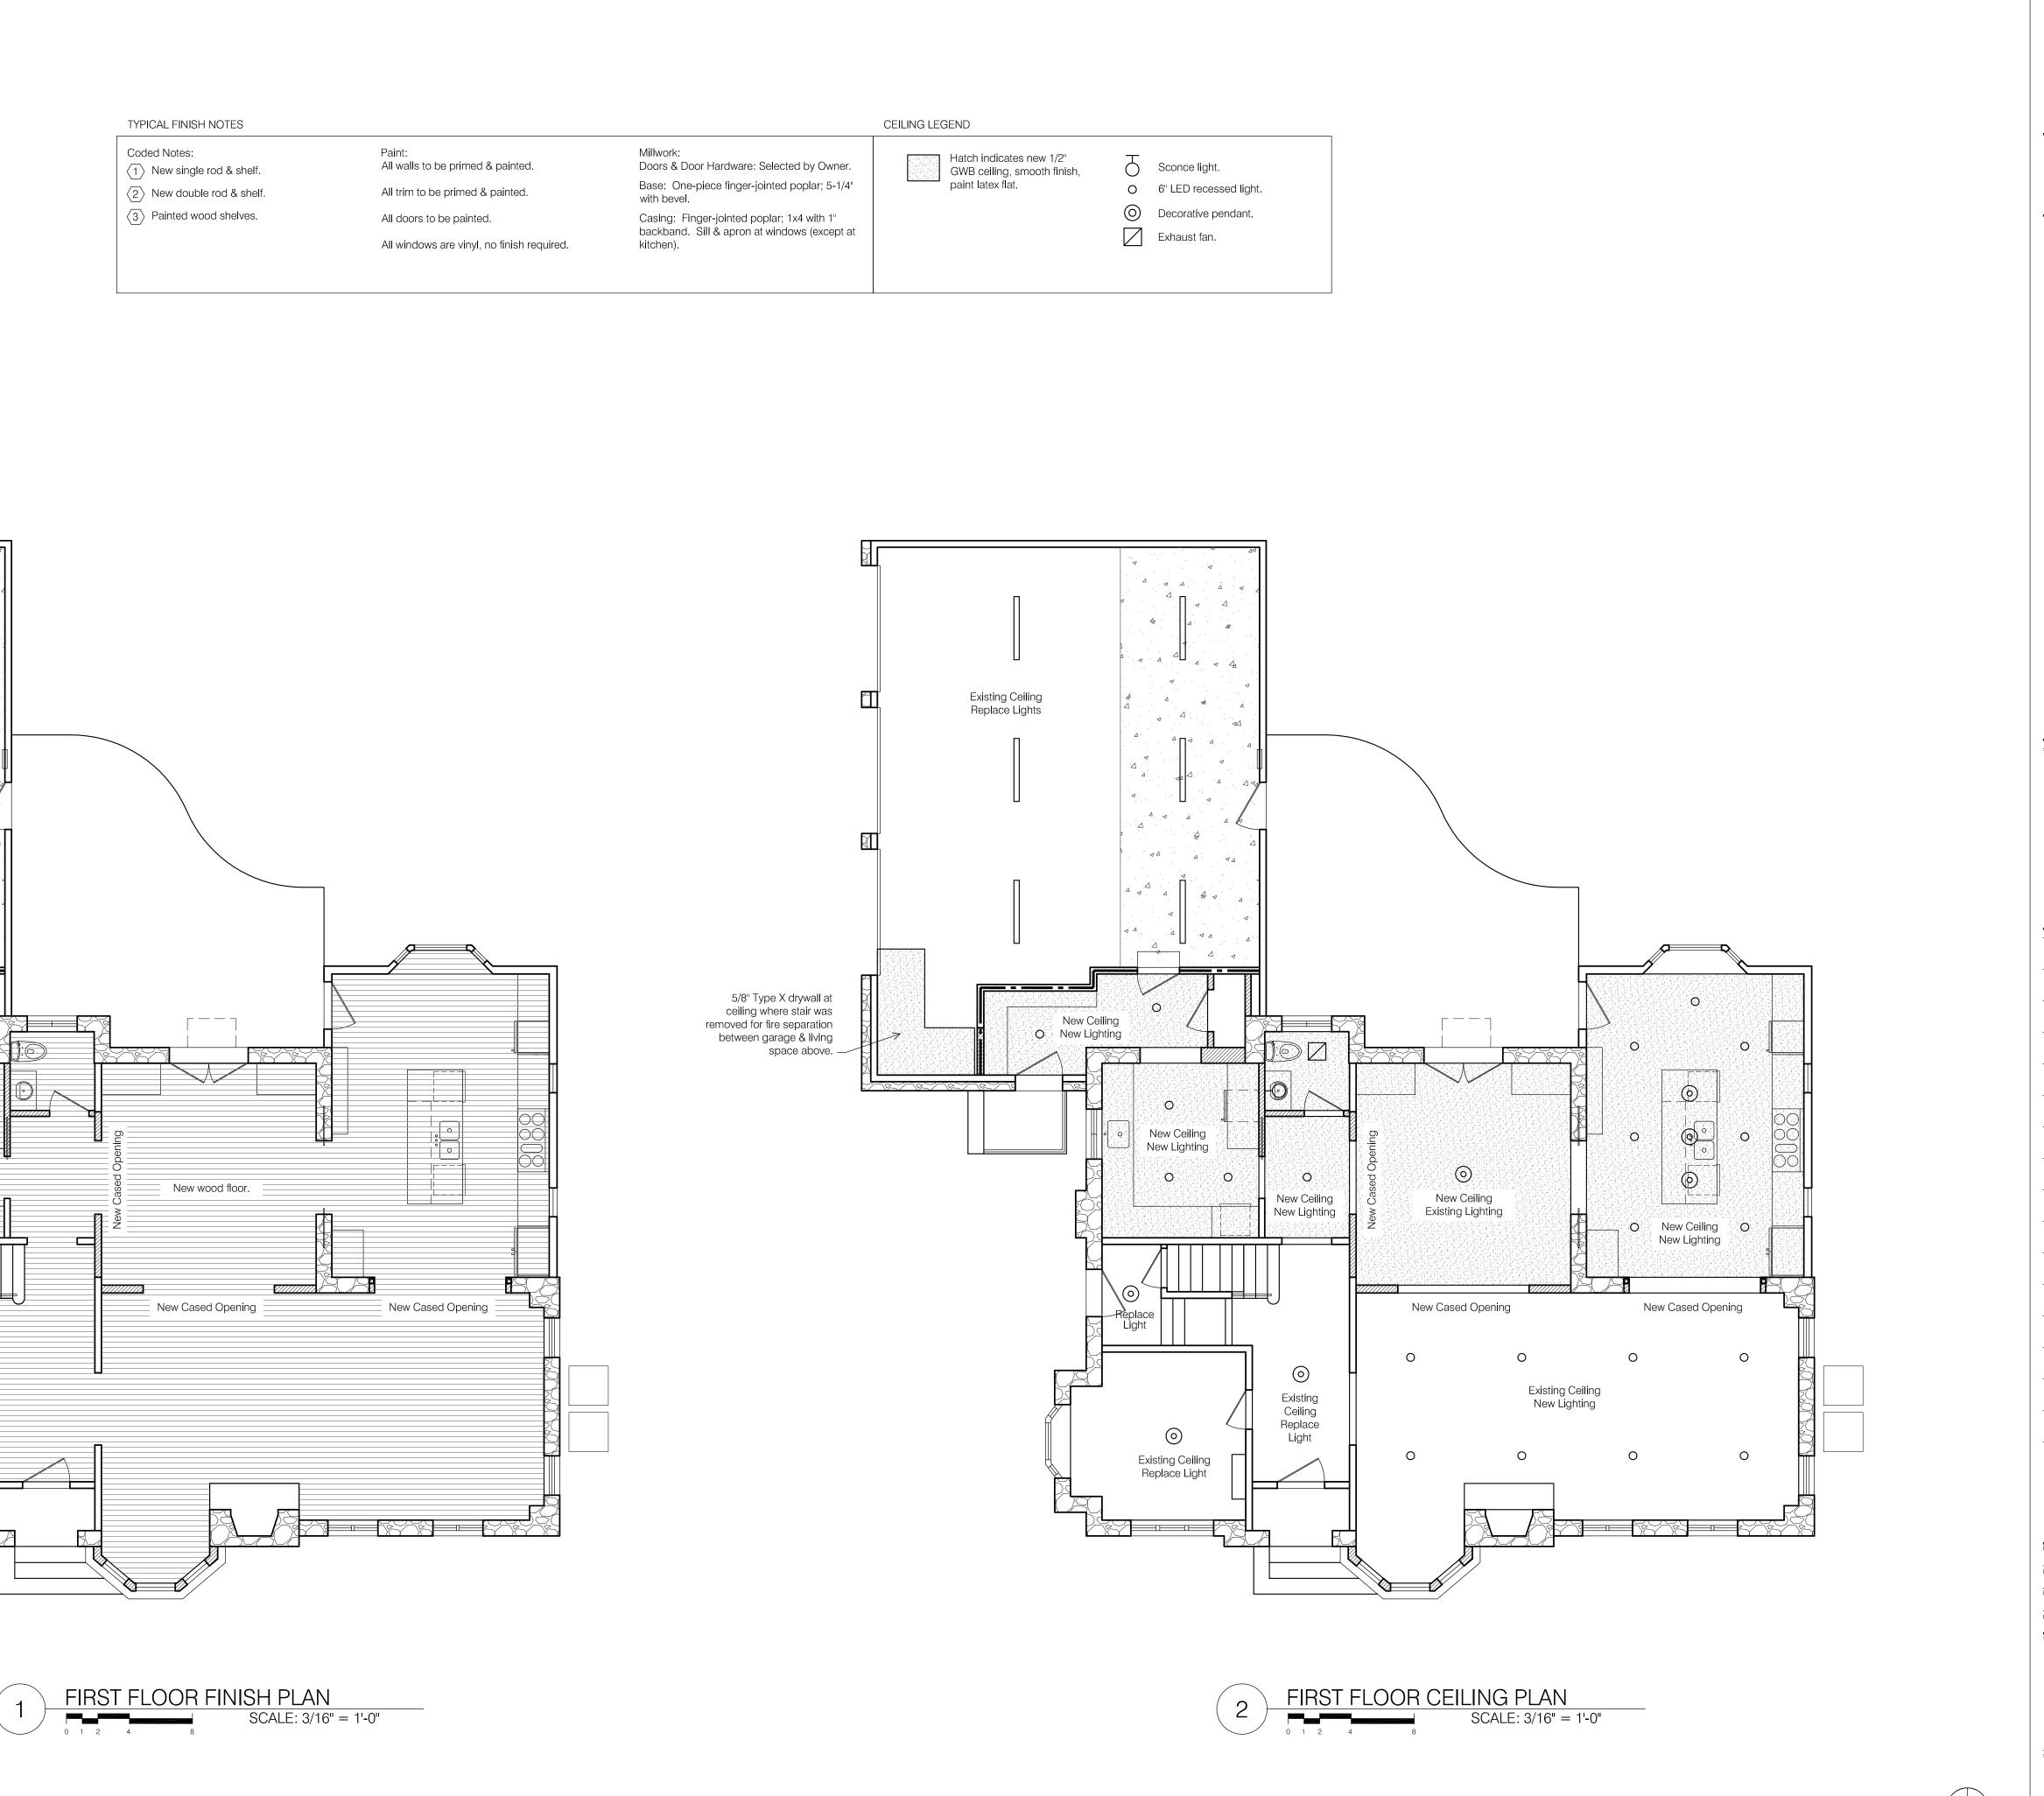

A A A A A

New guardrail. —

- - - -

New wood floor at stair landing. —

Refinish treads &

2342 Tremont Road Upper Arlington, Ohio 43221

Kutasay Residence 2342 Tremont Road

Architect: Brenda Parker The Columbus Architectural Studio 405 N Front Street Columbus, Ohio 43215 t: 614.586.5514 brenda.parker@cbusarch.com

Upper Arlington, Ohio 43221





July 2, 2024


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FIRST FLOOR FINISH PLANS

A3.1



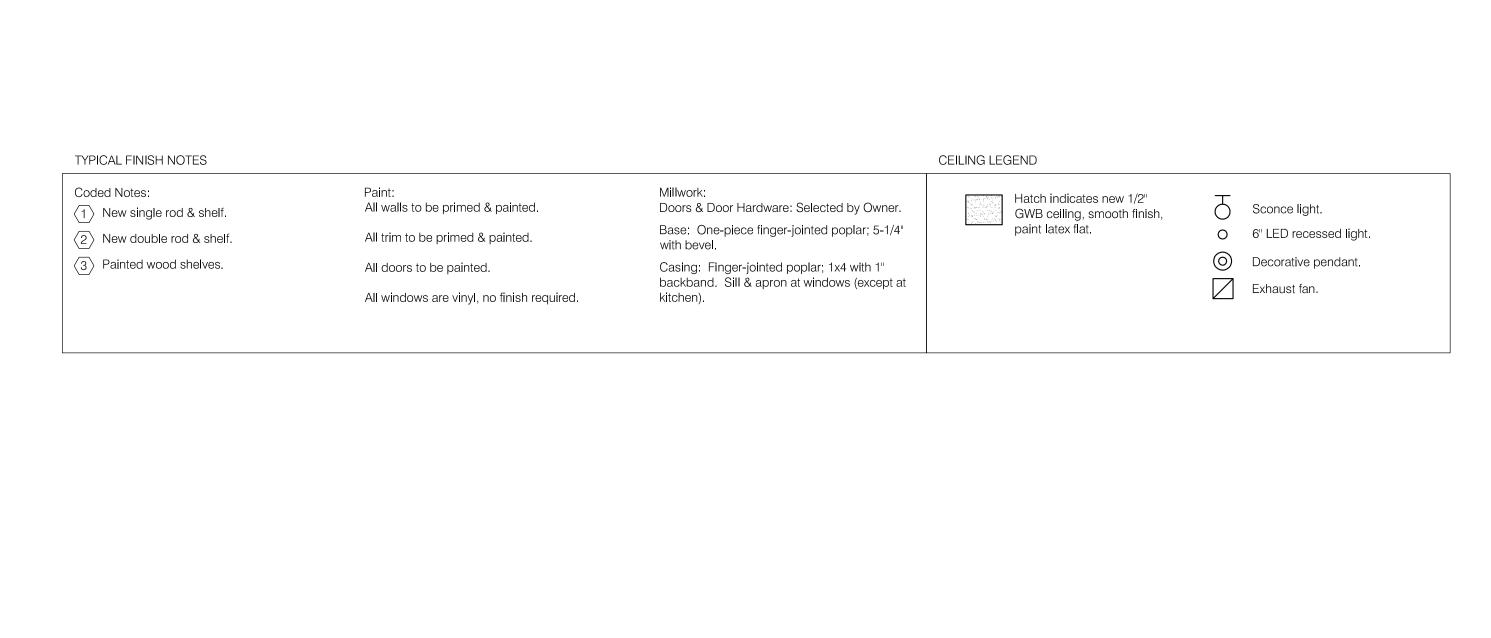

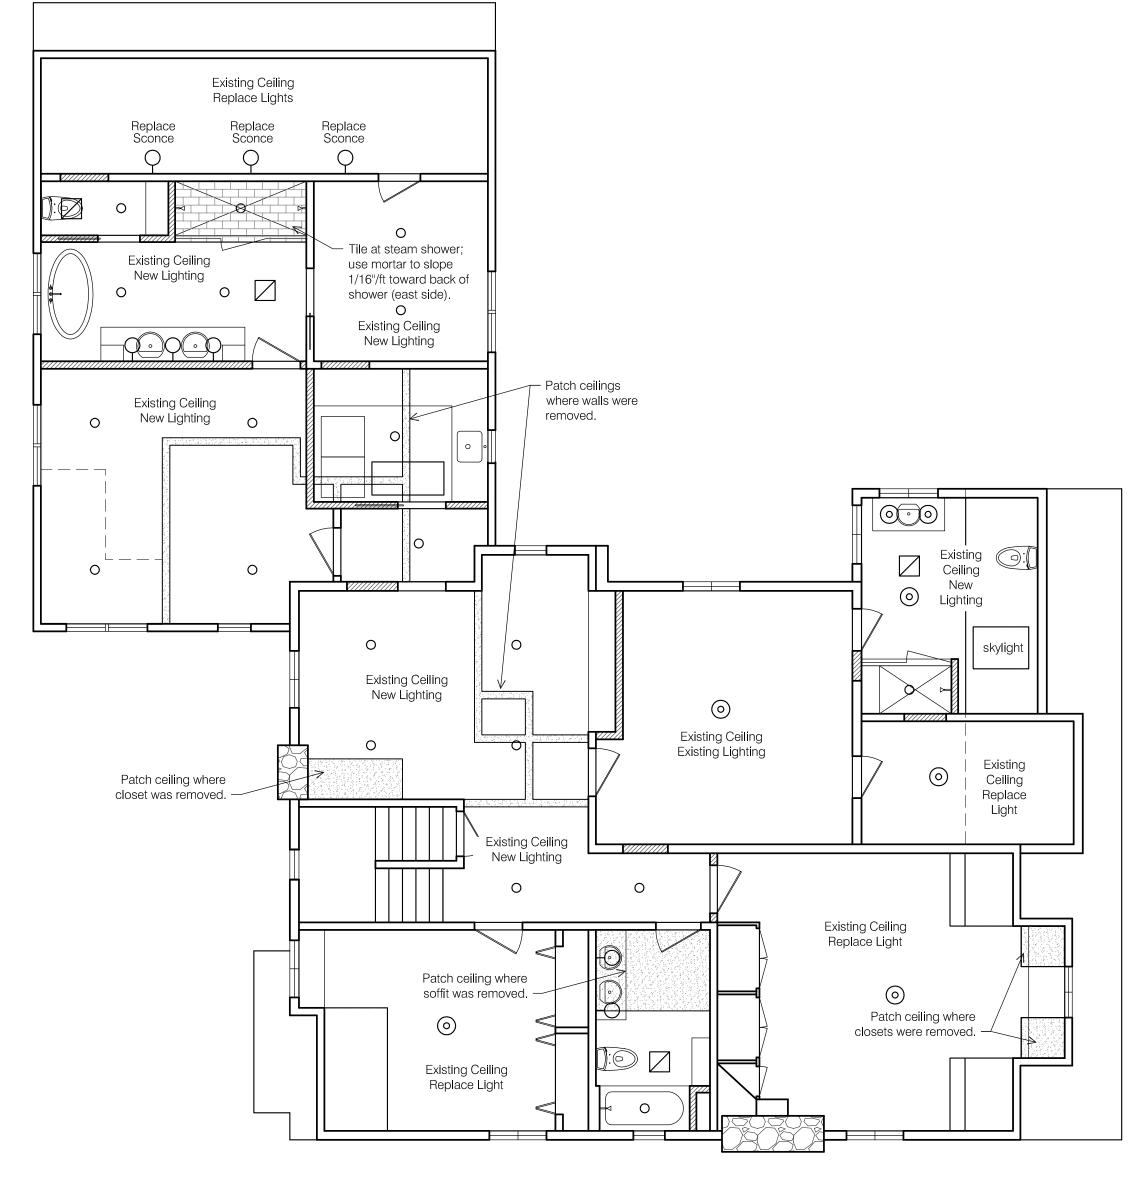

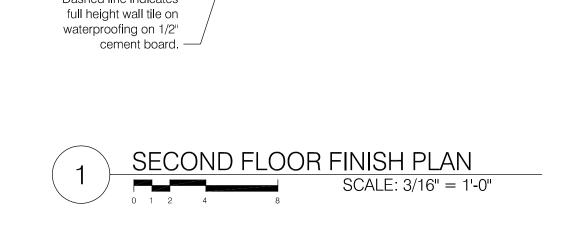Mew tile on 1/4"

cement board.

Tile on shower waterproofing system. —

Solid surface sill. -

All glass shower

Dashed line indicates

New carpet.

full height wall tile on + + waterproofing on 1/2"+ + cement board.

enclosure. —

New tile on 1/4"

+ Solid surface

+ at shower

New carpet.

New carpet.

Tile on shower waterproofing system.

Solid surface sill. -

All glass shower

Dashed line indicates

enclosure. -

wainscot tile. -

Dashed line indicates full height wall tile on waterproofing on 1/2" cement board. — New carpet.

- New tile on 1/4" cement board.

New wood floor.

New carpet.

Dashed line indicates

New tile on 1/4"

cement board.

New carpet.

New wood floor at stair landing. —

Refinish treads &

2 SECOND FLOOR CEILING PLAN
SCALE: 3/16" = 1'-0"

2342 Tremont Road Upper Arlington, Ohio 43221

Owner:
Kutasay Residence
2342 Tremont Road
Upper Arlington, Ohio 43221

Architect:
Brenda Parker
The Columbus Architectural Studio
405 N Front Street
Columbus, Ohio 43215
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brenda.parker@cbusarch.com

seal/signature



rev. date description

ey plan

July 2, 2024

Permit Set
project number
2342 TR
sheet title

SECOND FLOOR FINISH PLANS

A3.2



2342 Tremont Road
Upper Arlington, Ohio 43221

Owner: Kutasay Residence 2342 Tremont Road Upper Arlington, Ohio 43221

Architect:

Brenda Parker
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Columbus, Ohio 43215
t: 614.586.5514
brenda.parker@cbusarch.com

seal/signature



rev, date description

key plan

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project number
2342 TR

INTERIOR ELEVATIONS

A4.1



2342 Tremont Road Upper Arlington, Ohio 43221

Owner: Kutasay Residence 2342 Tremont Road Upper Arlington, Ohio 43221

Architect:

Brenda Parker
The Columbus Architectural Studio
405 N Front Street
Columbus, Ohio 43215
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brenda.parker@cbusarch.com

oppl/signature



rv. date description

July 2, 2024

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project number 2342 TR
sheet title

INTERIOR ELEVATIONS

A4.2

2342 Tremont Road Upper Arlington, Ohio 43221 ELECTRIC LEGEND Wall sconce light. ► Comply with current version \$ Electric switch. CMD Carbon monoxide detector. of NEC. Undercabinet light. LED recessed light. Electric switch with dimmer. ©D Dual sensing photoelectric and ionization smoke detector. Note: 120 volt AFCI Protected Receptacle Outlets are required at the following locations: Pendant light. Hard-wired with battery backup. Bedrooms, Living Rooms, Dining Rooms, Rec Rooms, Hallways, Kitchens, Laundry Rooms. Electric outlet; height as Ceiling fan. All detectors to be interconnected. indicated. Exhaust fan. GFCI Electric outlet with ground fault Kutasay Residence Note: Electrical contractor to determine best method circuit interrupter; height as 2342 Tremont Road Exhaust fan w/ light. for re-configuring power & lighting. Information shown on the drawings indicates the desired end solution. Upper Arlington, Ohio 43221 indicated. Architect: Brenda Parker The Columbus Architectural Studio 405 N Front Street Columbus, Ohio 43215 t: 614.586.5514 brenda.parker@cbusarch.com EXIST GARAGE SLAB-ON-GRADE EXIST TO CRAWL New sanitary piping from Guest Bath. EXIST CRAWL SPACE? CRAWL SPACE? EXIST BASEMENT Extend gas line to new range location. - Note: At crawl space, provide conditioned supply air at a rate equal to 1 cu ft per minute for each 50 sf of under-floor area. + Return Duct + EXIST CRAWL SPACE condensing unit serving Install new EXIST CRAWL SPACE high-efficiency natural gas furnace. Vent to exterior thru Install new condensing unit. Extend gas line to new furnace location. BASEMENT

BASEMENT ELECTRIC PLAN

SCALE: 3/16" =

EXIST GARAGE SLAB-ON-GRADE

CRAWL

Existing electric panel to remain.

BASEMENT

o sanitary

BASEMENT HVAC/PLUMBING PLAN

SCALE: 3/16" = 1'-0"


MEP.0


MEP PLANS


July 2, 2024

Permit Set

2342 TR

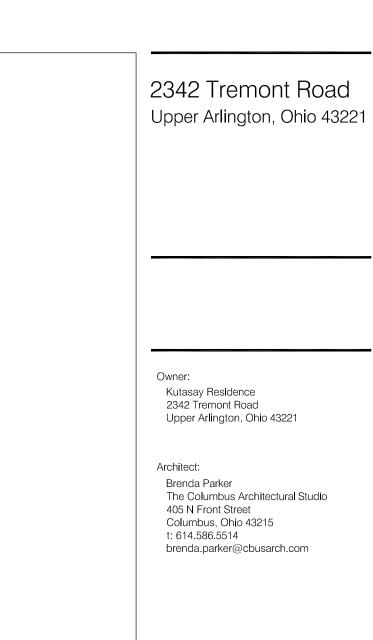

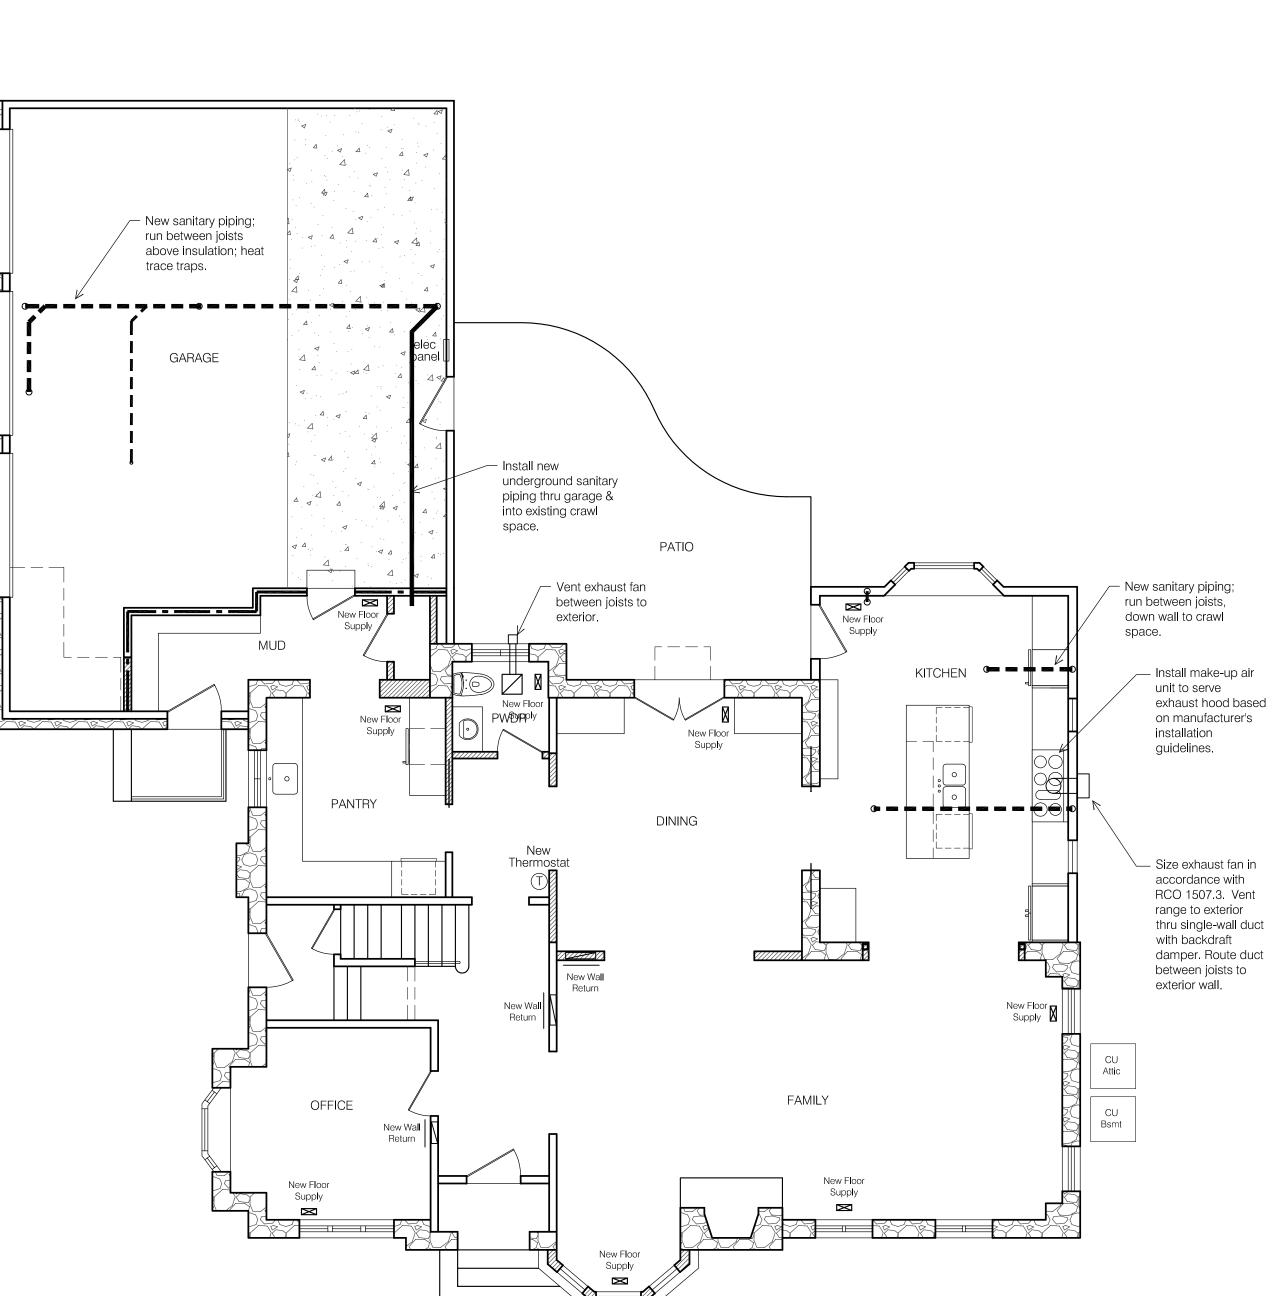

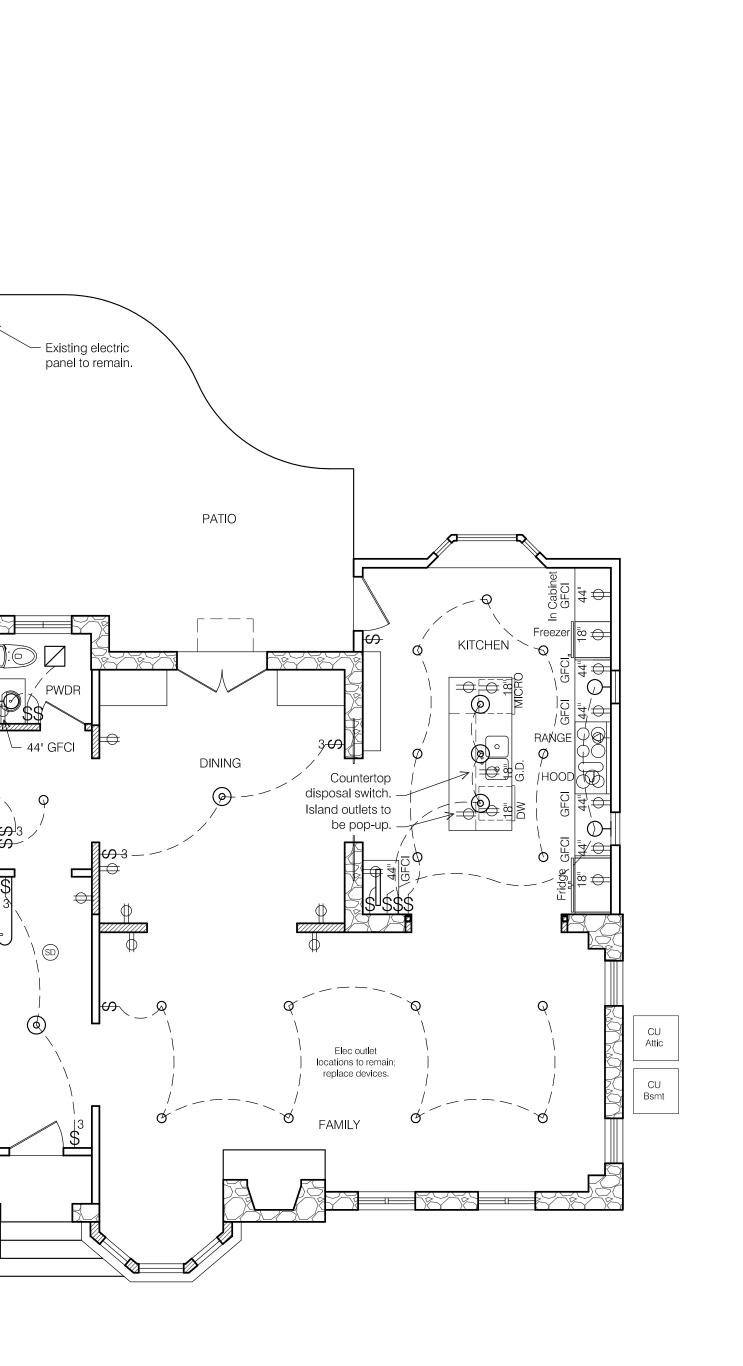

ELECTRIC LEGEND

panel [

OFFICE

Elec outlet locations to remain; replace devices.

CMD Carbon monoxide detector.

©D Dual sensing photoelectric and ionization smoke detector.

Hard-wired with battery backup.

All detectors to be interconnected.

Wall sconce light.

Pendant light.

Exhaust fan.

O LED recessed light.

Exhaust fan w/ light.

\$ Electric switch.

indicated.

indicated.

Electric switch with dimmer.

Electric outlet; height as

GFCI Electric outlet with ground fault

circuit interrupter; height as

Undercabinet light.

Ceiling fan.

Note: Electric installation to comply with current version

Note: 120 volt AFCI Protected Receptacle Outlets are

Bedrooms, Living Rooms, Dining Rooms, Rec Rooms, Hallways, Kitchens, Laundry Rooms.

Note: Electrical contractor to determine best method

for re-configuring power & lighting. Information shown on the drawings indicates the desired end solution.

required at the following locations:

of NEC.

FIRST FLOOR ELECTRIC PLAN

FIRST FLOOR HVAC/PLUMBING PLAN SCALE: 3/16" = 1'-0"

July 2, 2024


Permit Set


FIRST FLOOR


MEP.1

MEP PLANS

2342 TR

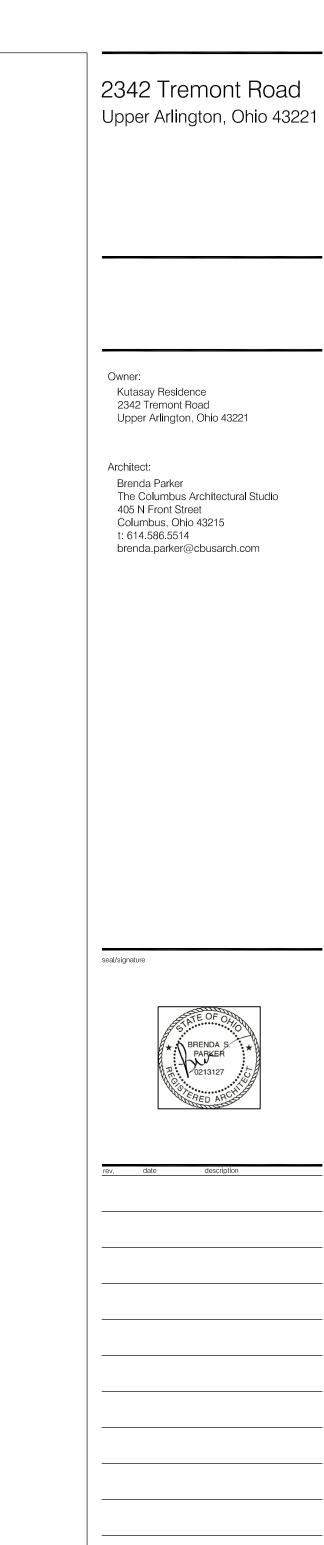

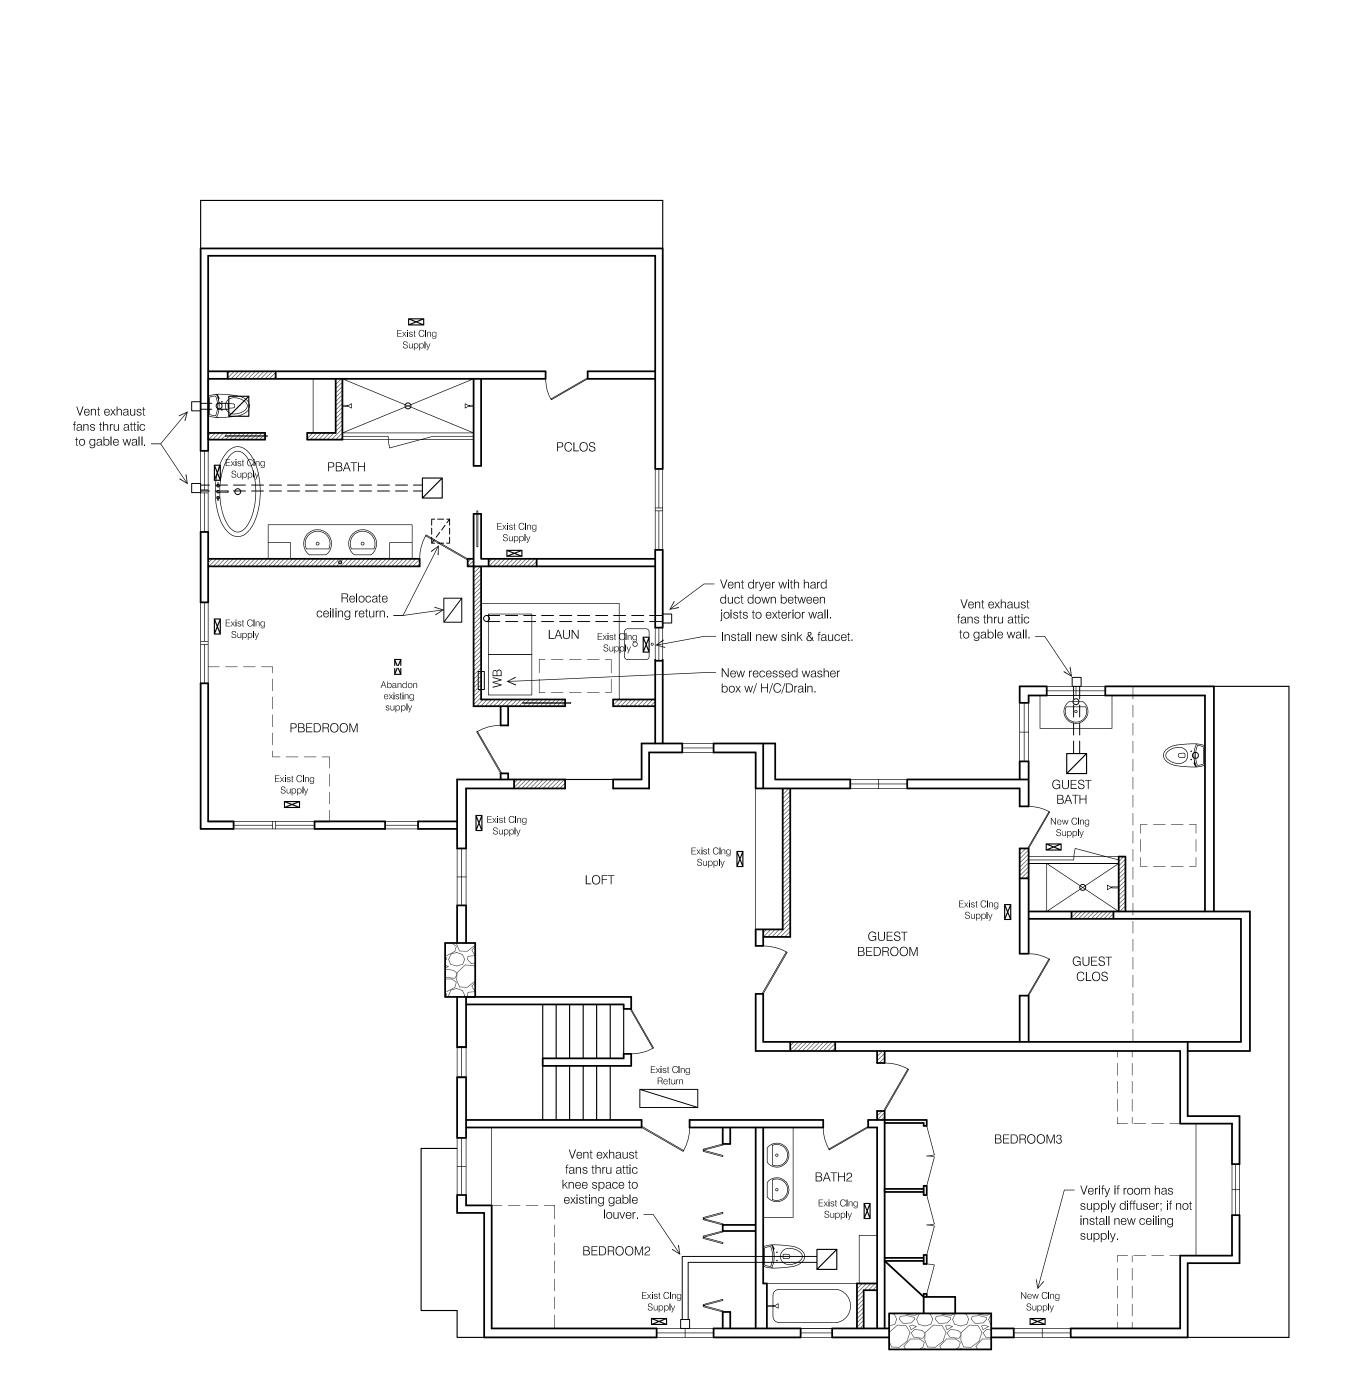

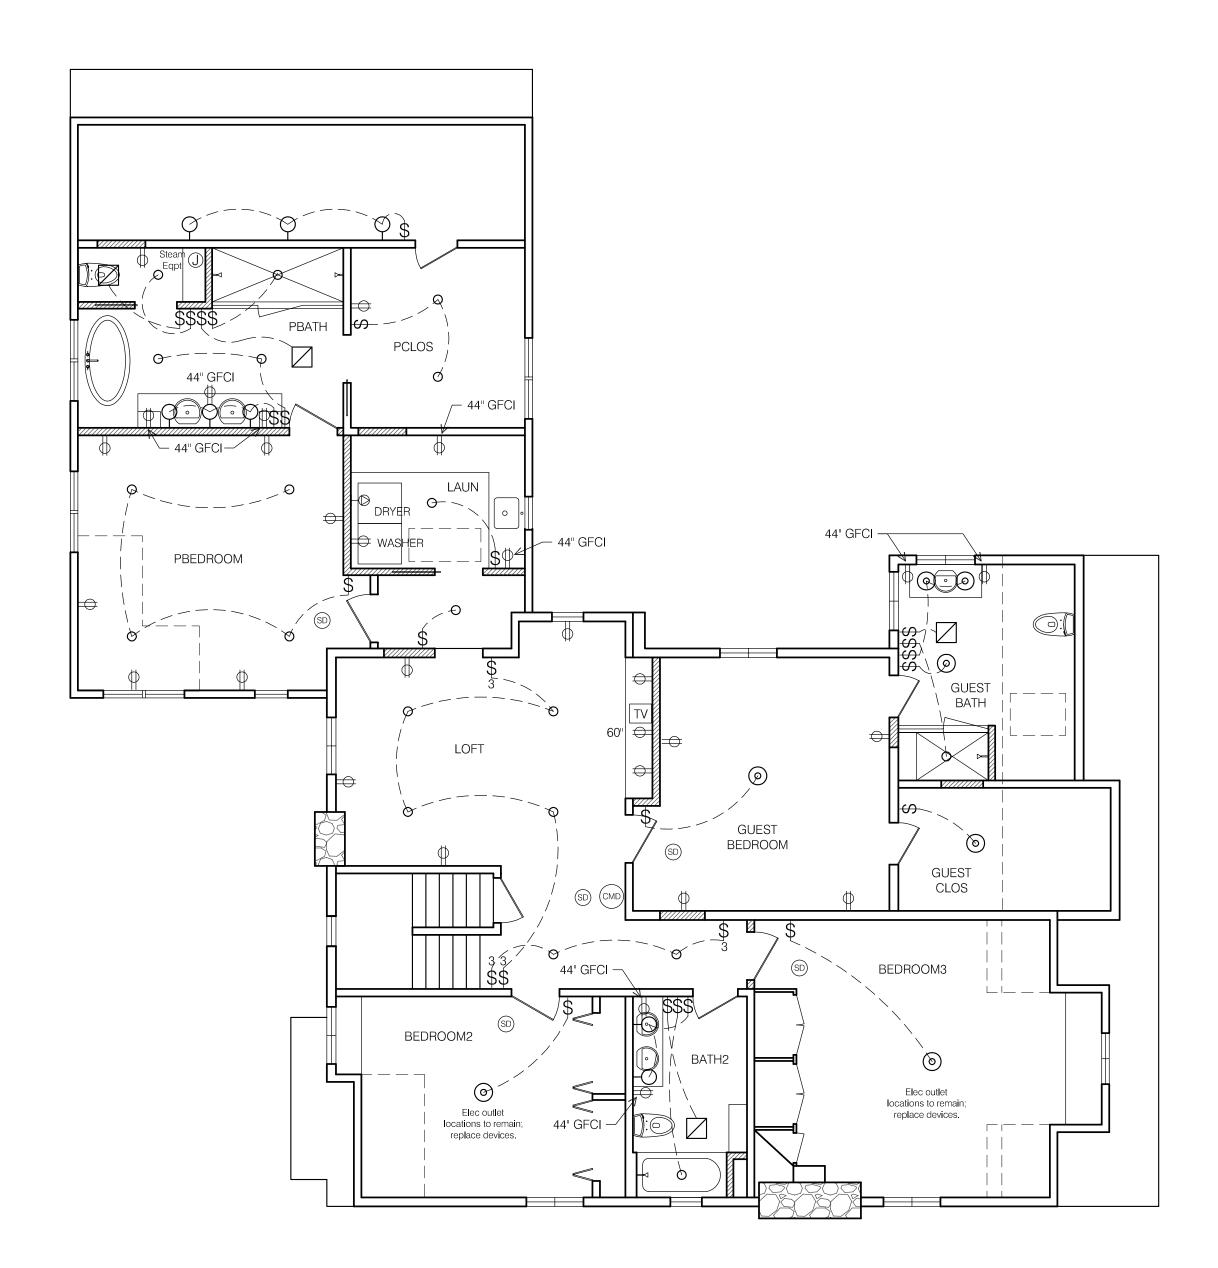

SECOND FLOOR ELECTRIC PLAN

SCALE: 3/16" = 1'-0"

ELECTRIC LEGEND

CMD Carbon monoxide detector.

©D Dual sensing photoelectric and ionization smoke detector.

Hard-wired with battery backup.

All detectors to be interconnected.

Wall sconce light.

Pendant light.

Exhaust fan.

O LED recessed light.

Exhaust fan w/ light.

\$ Electric switch.

indicated.

indicated.

Electric switch with dimmer.

Electric outlet; height as

GFCI Electric outlet with ground fault

circuit interrupter; height as

Undercabinet light.

Ceiling fan.

Note: Electric installation to comply with current version

Note: 120 volt AFCI Protected Receptacle Outlets are

Bedrooms, Living Rooms, Dining Rooms, Rec Rooms, Hallways, Kitchens, Laundry Rooms.

Note: Electrical contractor to determine best method

for re-configuring power & lighting. Information shown on the drawings indicates the desired end solution.

required at the following locations:

of NEC.

2 SECOND FLOOR HVAC/PLUMBING PLAN
SCALE: 3/16" = 1'-0"

July 2, 2024

Permit Set

SECOND FLOOR

MEP PLANS

MEP.2

2342 TR